

revision details


A	07/02/22	ISSUED FOR PLANNING
B	11/09/23	ISSUED FOR PART 8 APPLICATION

OSI LICENCE NO EN 0014523  
 ALL LEVELS ARE IN METERS AND REFER TO ORDNANCE SURVEY DATUM (MALIN HEAD). CO-ORDINATES ARE TO ITM.


LEGEND

- SITE OUTLINE IN RED
- PROPOSED ROADWAY (BITUMEN SURFACE)
- PROPOSED RAISED TABLE (HOT ROLLED COLOURED ASPHALT SURFACE)
- PROPOSED 80MM THICK PERMEABLE PAVING BLOCKS (TO LANDSCAPE ARCHITECT SPECIFICATIONS)
- PROPOSED 60MM THICK PERMEABLE PAVING BLOCKS (TO LANDSCAPE ARCHITECT SPECIFICATIONS)
- PROPOSED PAVING BLOCKS (TO LANDSCAPE ARCHITECT SPECIFICATIONS)
- EXPOSED AGGREGATE CONCRETE SURFACE
- INSITU CONCRETE SURFACE
- PROPOSED LANDSCAPE AREA / TREE PLANTERS (SEE LANDSCAPE ARCHITECT DRAWINGS)
- PROPOSED PAINTED PEDESTRIAN PATH

PROPOSED TYPICAL PRECAST HALF BATTER KERB (UPSTAND BETWEEN 100-150MM)  
 - PROPOSED DROP RAMP WITH BUFF BLISTER TACTILE PAVING

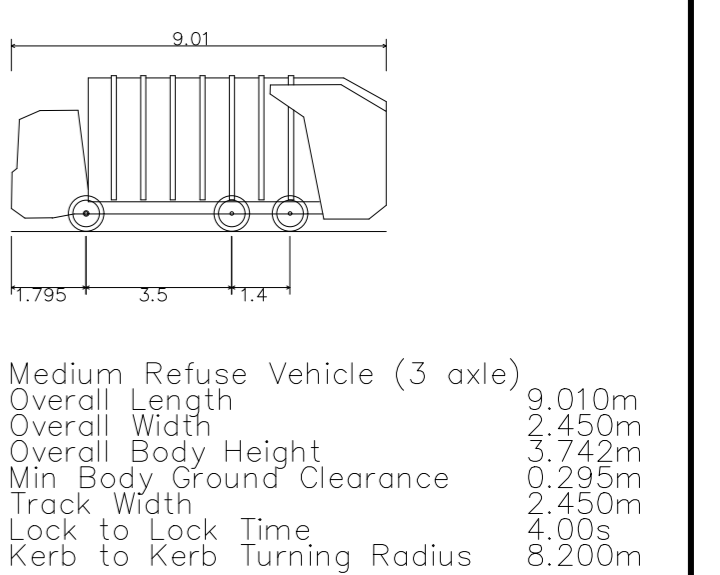

SWEPT PATH VEHICLE PROFILE SCALE NTS

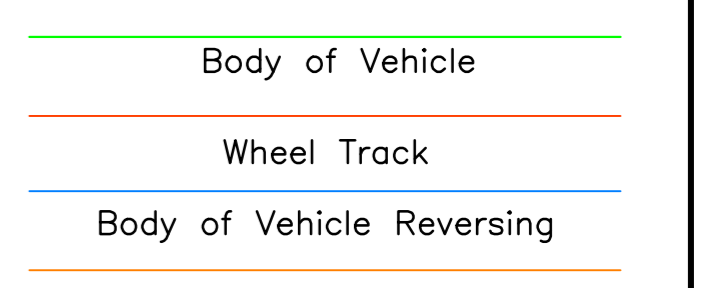

NOTE

- LOCATION, THICKNESS, SIZE ETC. OF ROAD SIGNS AND MARKINGS SHALL COMPLY WITH TRAFFIC SIGNS MANUAL (TSM) BY THE DEPARTMENT OF TRANSPORT, TOURISM AND SPORT.
- BLISTER TACTILE SURFACES AND DROP (DISHED) RAMPS SHALL BE PROVIDED AT ALL UNCONTROLLED CROSSING POINTS.
- DROP (DISHED) RAMP DETAILS TO COMPLY WITH DIAGRAM 13.1, "TRAFFIC MANAGEMENT GUIDELINES" BY DOT.
- TACTILE PAVING TO COMPLY WITH CLAUSE 13.3, "TRAFFIC MANAGEMENT GUIDELINES" BY DOT.
- AT UNCONTROLLED CROSSINGS THE TACTILE PAVING SURFACE SHALL BE CONSTRUCTED OF BUFF OR GRAY (OTHER THAN RED) BLISTER TILES AS PER TII CC-SCD-05014.
- THE BACK EDGE OF THE TACTILE SURFACE SHOULD BE AT RIGHT ANGLES TO THE DIRECTION OF CROSSING. THIS MAY NOT NECESSARILY BE PARALLEL TO THE KERB.
- ROAD MARKINGS AND SIGNAGE WERE DESIGNED FOR POSTED SPEED 30KM/H. SIGN PLACEMENT TO COMPLY WITH CLAUSE 1.3.16, CHAPTER 1, TSM (MIN. HORIZONTAL CLEARANCE BETWEEN FOOTPATH EDGE AND SIGN POLE TO BE 1200MM).

THIS DRAWING IS TO BE READ IN CONJUNCTION WITH ALL OTHER DCE DRAWINGS

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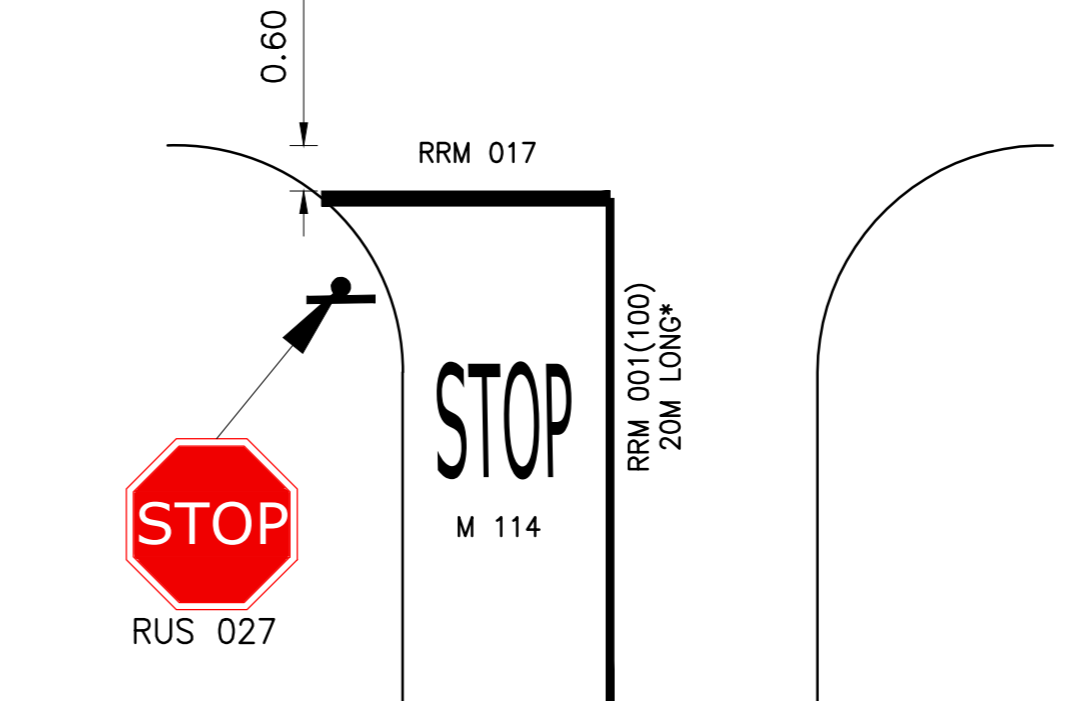
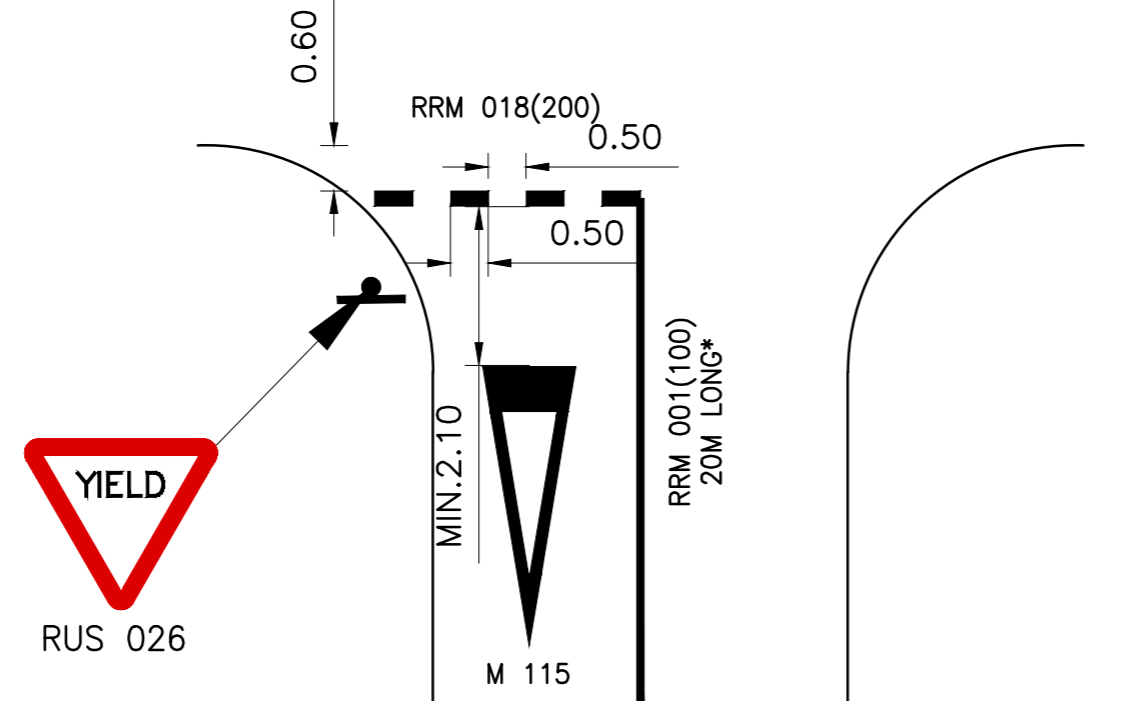
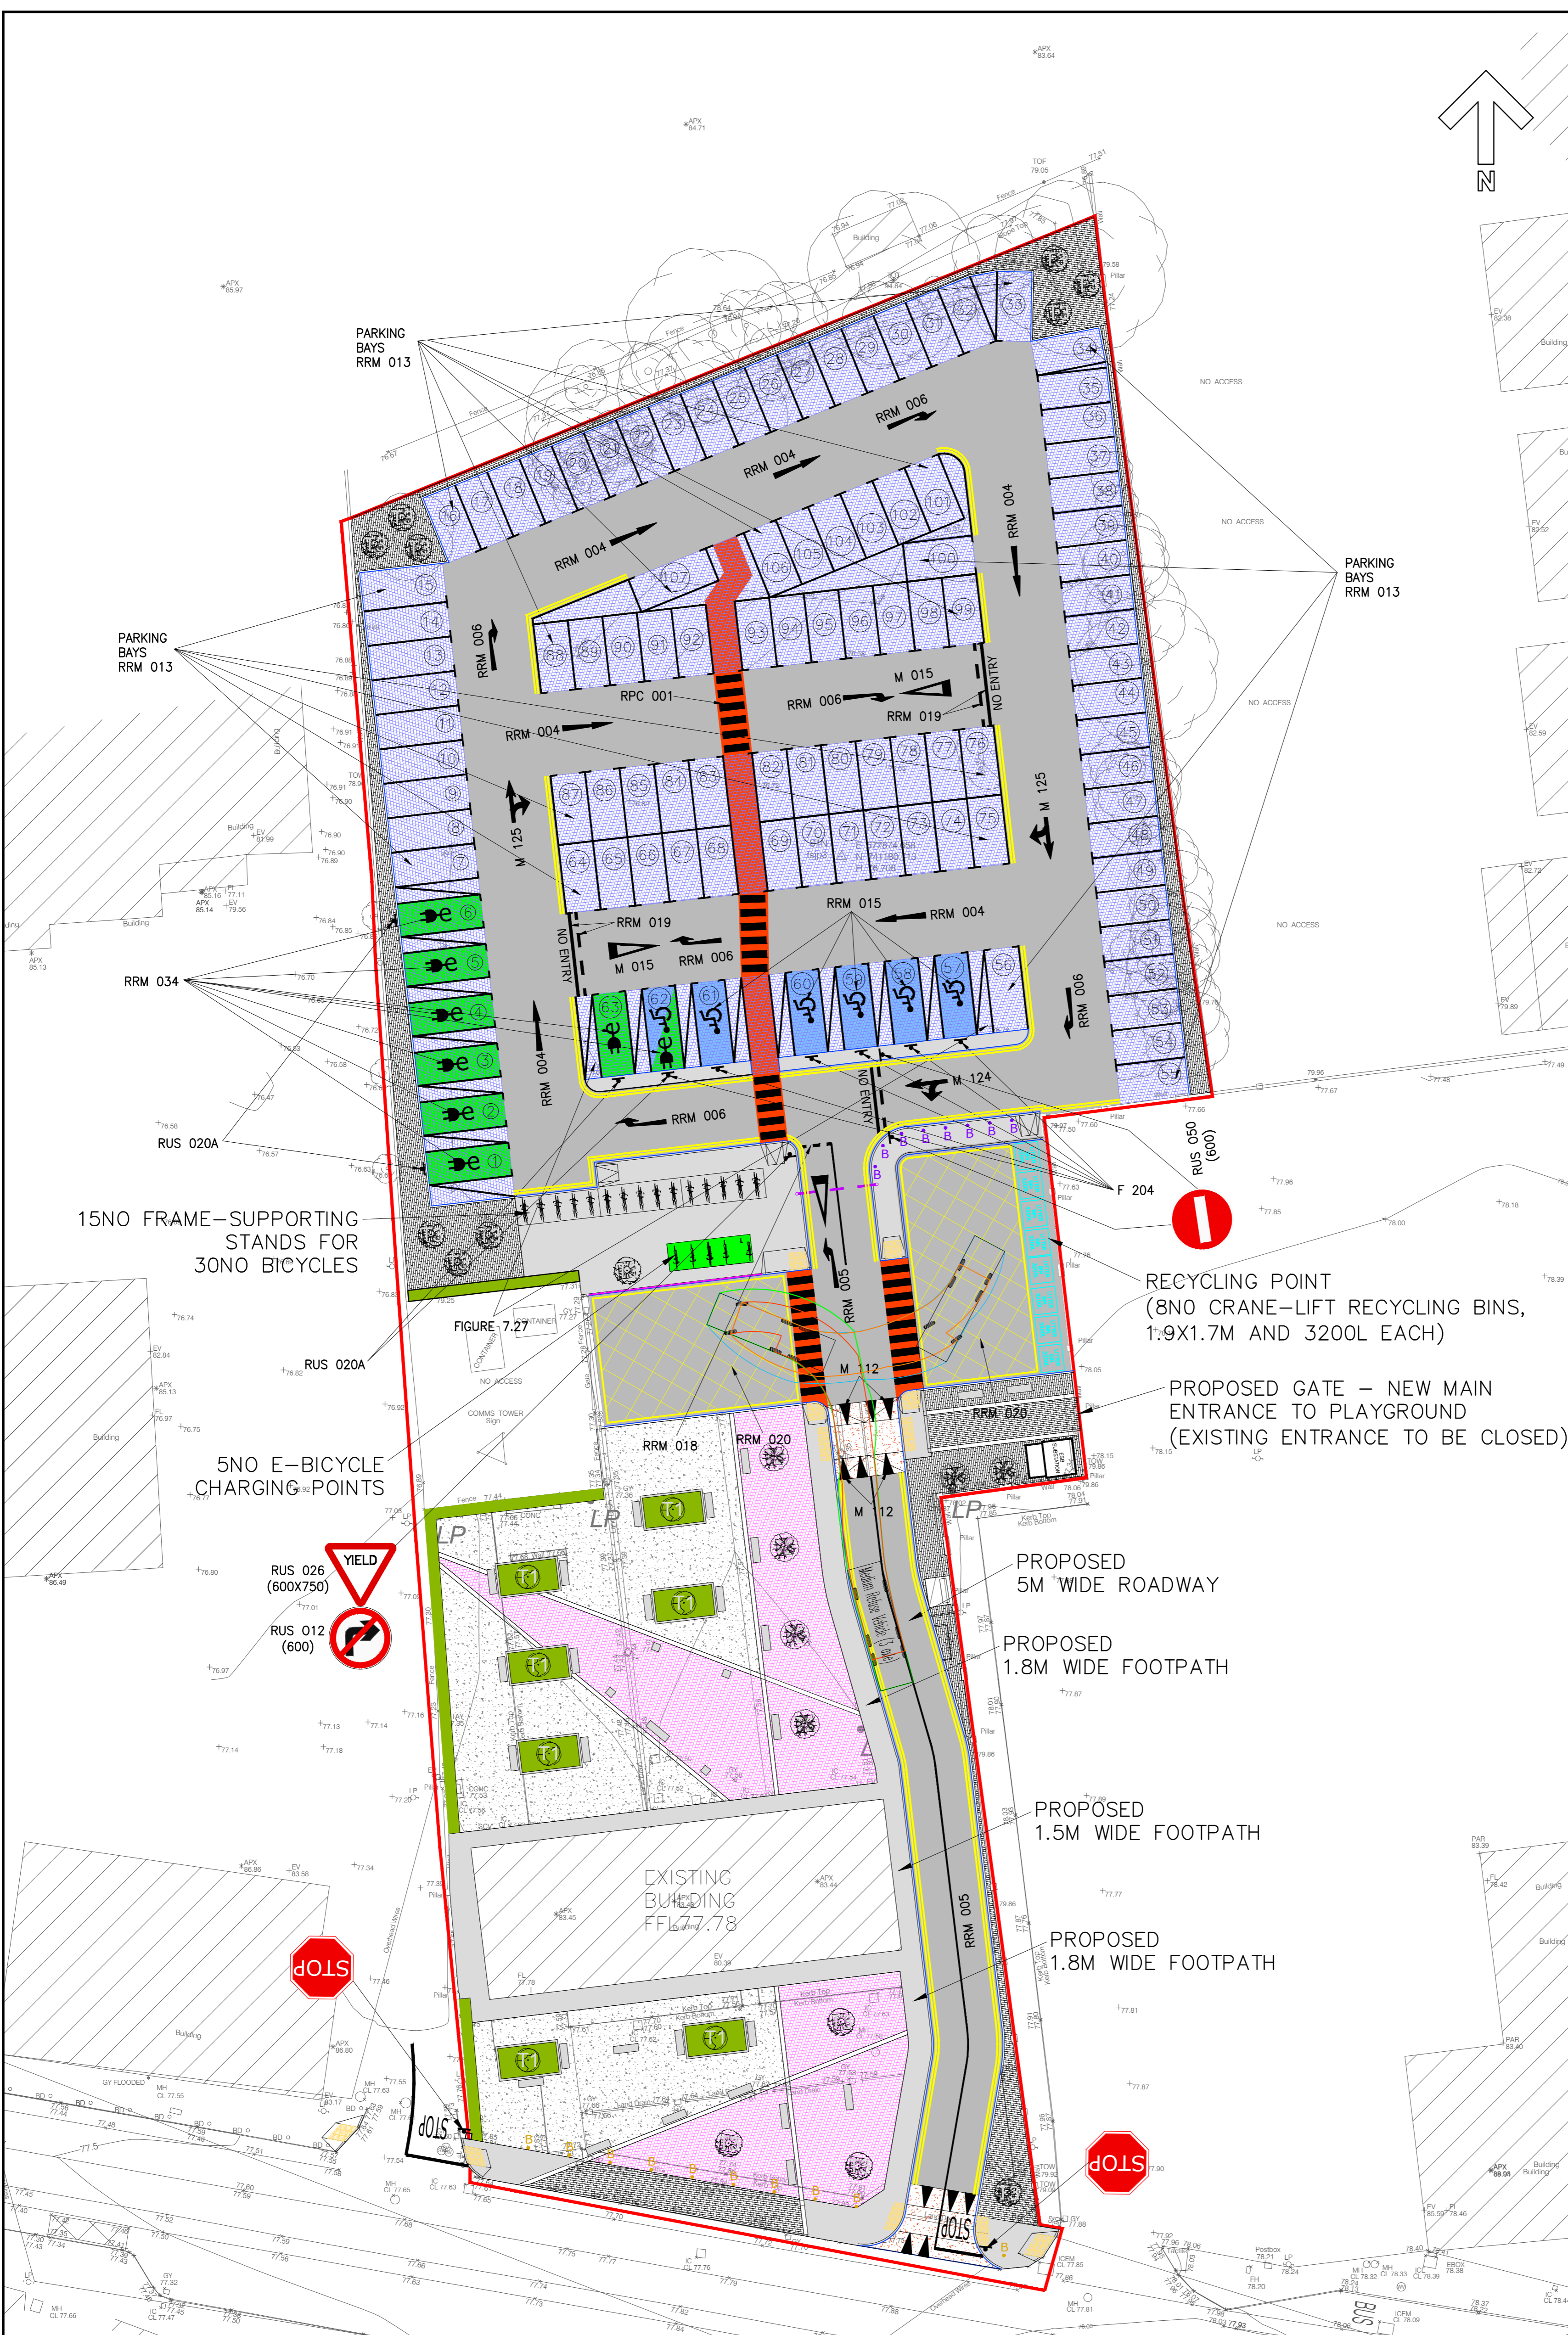
Client: MEATH COUNTY COUNCIL

comhairle chontae na mí meath county council

Job Title: ENFIELD - TOWN CENTRE PARKING

Drawing Title: PROPOSED PAVING PLAN, ROAD MARKINGS AND SIGNS

Scale:	1:250@A1	Dwg no:	C03
Drawn by:	KK	Job no.:	4456
Checked by:	GJB	Rev. no.:	B
File no.:	4456 C03	Date:	07/02/22



\*THIS MAY BE REDUCED TO A MINIMUM OF 8M AS SITE CONDITIONS REQUIRE. ON ROADS LESS THAN 5.3M WIDTH ONLY, THE CENTRE LINE MARKING MAY BE REDUCED TO 2M.

FIGURE 7.36: TYPICAL EXAMPLE OF PRIORITY-CONTROLLED YIELD JUNCTION SCALE 1:100

FIGURE 7.35: EXAMPLE OF PRIORITY-CONTROLLED STOP JUNCTION SCALE 1:100

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